

NOTICE TO BIDDERS

This Addendum is issued pursuant to the Conditions of the Contract and is hereby made part of the Contract Documents. The addendum serves to clarify, revise, and supersede information in the Project Manual, the Drawings, and previously issued Addenda. The Bidder shall acknowledge receipt of this Addendum in the appropriate space on the Bid Form. Failure to do so may subject the Bidder to disqualification. A list of attachments, if any, is part of this document.

The date for receipt of bids for this project is unchanged by this Addendum.

A. CLARIFICATIONS

- 1. Units have been changed to 3-ton units <u>without</u> hot gas reheat. Units also require a LON communication card.
- 2. Bipolar ionization units to be located in each SPHP unit. See specifications.
- 3. Instead of raising the existing pad, the units should be provided with a 6" curb as indicated on the schedule.

B. SPECIFICATION SECTIONS

- 1. Invitation for Construction Bids
 - a. See revised section.

C. GENERAL CONSTRUCTION DRAWINGS

- 1. Sheet GC101
 - a. See revised sheet.
- 2. Sheet M102
 - a. See revised sheet.
- 3. Sheet M103
 - a. See revised sheet.
- 4. Sheet M300
 - a. See revised sheet.
- 5. Sheet E102
 - a. See revised sheet.

Rock Hill School District Lesslie Elementary School HVAC Replacement ADDENDUM NO. 1 | May 18, 2023




ATTACHMENTS:

- 1. Invitation for Construction Bids
- 2. Drawing GC101
- 3. Drawing M102
- 4. Drawing M103
- 5. Drawing M300
- 6. Drawing E102

- End of Addendum -

INVITATION FOR CONSTRUCTION BIDS

PROJECT	PUN 00 00 14
PROJECT NAME: Lesslie Elementary School, Chiller Replacer	
PROJECT NUMBER: 22158	LOCATION: 250 Neely Store Rd, Rock Hill. SC
DESCRIPTION OF PROJECT: Replace existing packaged equi	• • • • • • • • • • • • • • • • • • • •
in the same location.	
OWNER	
OWNER NAME: Rock Hill Schools, York County School Distr	rict Three
ADDRESS: 2171 West Main Street	itt imtt
CITY: Rock Hill STATE: South C	Carolina ZIP: 29732
OWNER REPRESENTATIVE: Mr. Kim Melander	
PHONE: 803-981-1156 Emai	: kmelander@rhmail.org
ENGINEER	
ENGINEERING FIRM: Buford Goff & Associates, Inc.	
ADDRESS: 1331 Elmwood Avenue, Suite 200	
CITY: Columbia STATE: S.C	. ZIP: <u>29201</u>
ELECTRICAL REPRESENTATIVE: Ed Weaver	Email: ed.weaver@bgainc.com
MECHANICAL REPRESENTATIVE: Jonathan Burkett	Email: Jonathan.burkett@bgainc.com
	Email:
PHONE: (803) 254-6302	
ARCHITECT	
ARCHITECTURAL FIRM: <u>N/A</u>	
ADDRESS:	
CITY: STATE:	ZIP:
ARCHITECTURAL REPRESENTATIVE:	
PHONE:Email	:
PRE-BID (NON-MANDATORY)	
	TIME: 3:30 PM
PRE-BID LOCATION: <u>Lesslie Elementary School, 250 Neely</u>	Store Rd, Rock Hill. SC
COMMENTS:	
BID	
BID DATE: <u>5/30/2023</u>	TIME: <u>10:00 AM</u>
LOCATION: <u>District Office</u> , 386 East Black Street, Rock Hill,	SC 29730
BID SECURITY	
Bid security is required in an amount not less than 5% of the Bas	e Bid.
BONDS	
	ce and Labor and Material Payment Bonds, each in the amount of
100% of the Contract Price	ce and Labor and Material Layment Bonds, each in the amount of
PLANS	
AVAILABLE FROM: Administration@bgainc.com	\(\)
	isted source(s) to be listed as an official plan holder. Bidders that
	n risk. All written communications with official plan holders and
bidders will be via email.	
******************	**************
APPROVED BY:	
(PROJECT ENGINE	EER) (DATE)

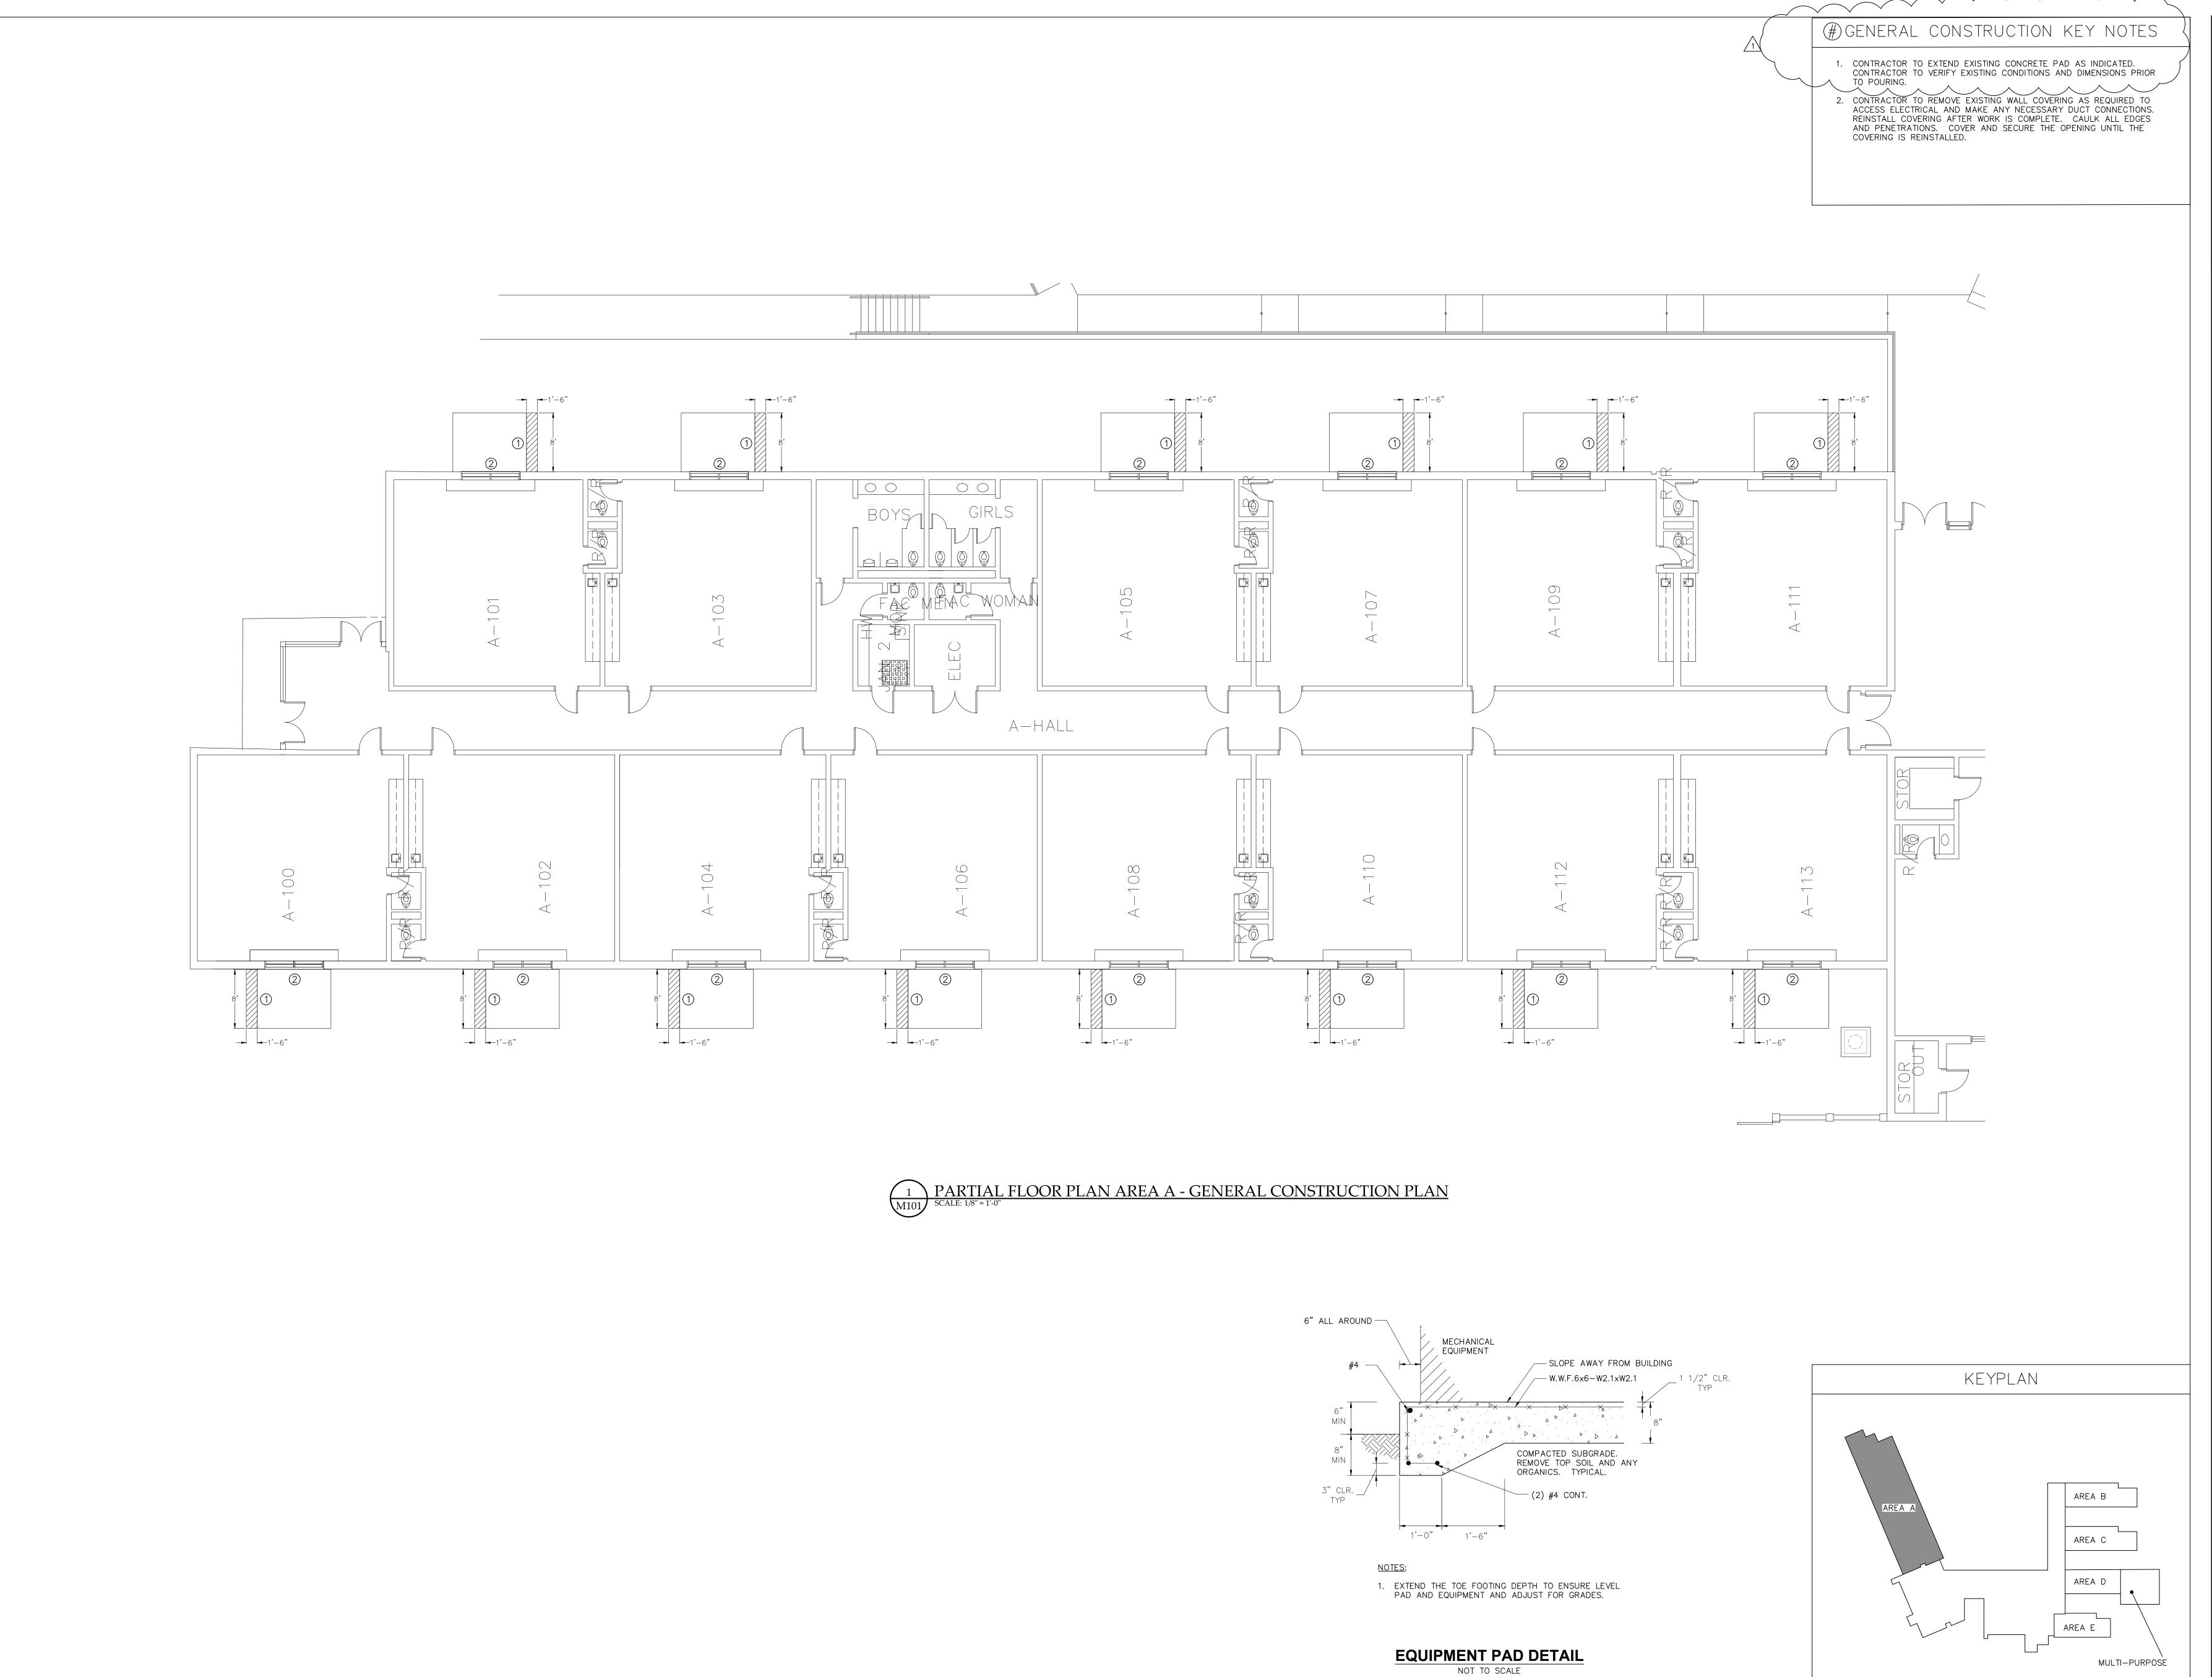

Project Engineer: JEB JEB


No. 1-ADN 1 Date 05/10/2023


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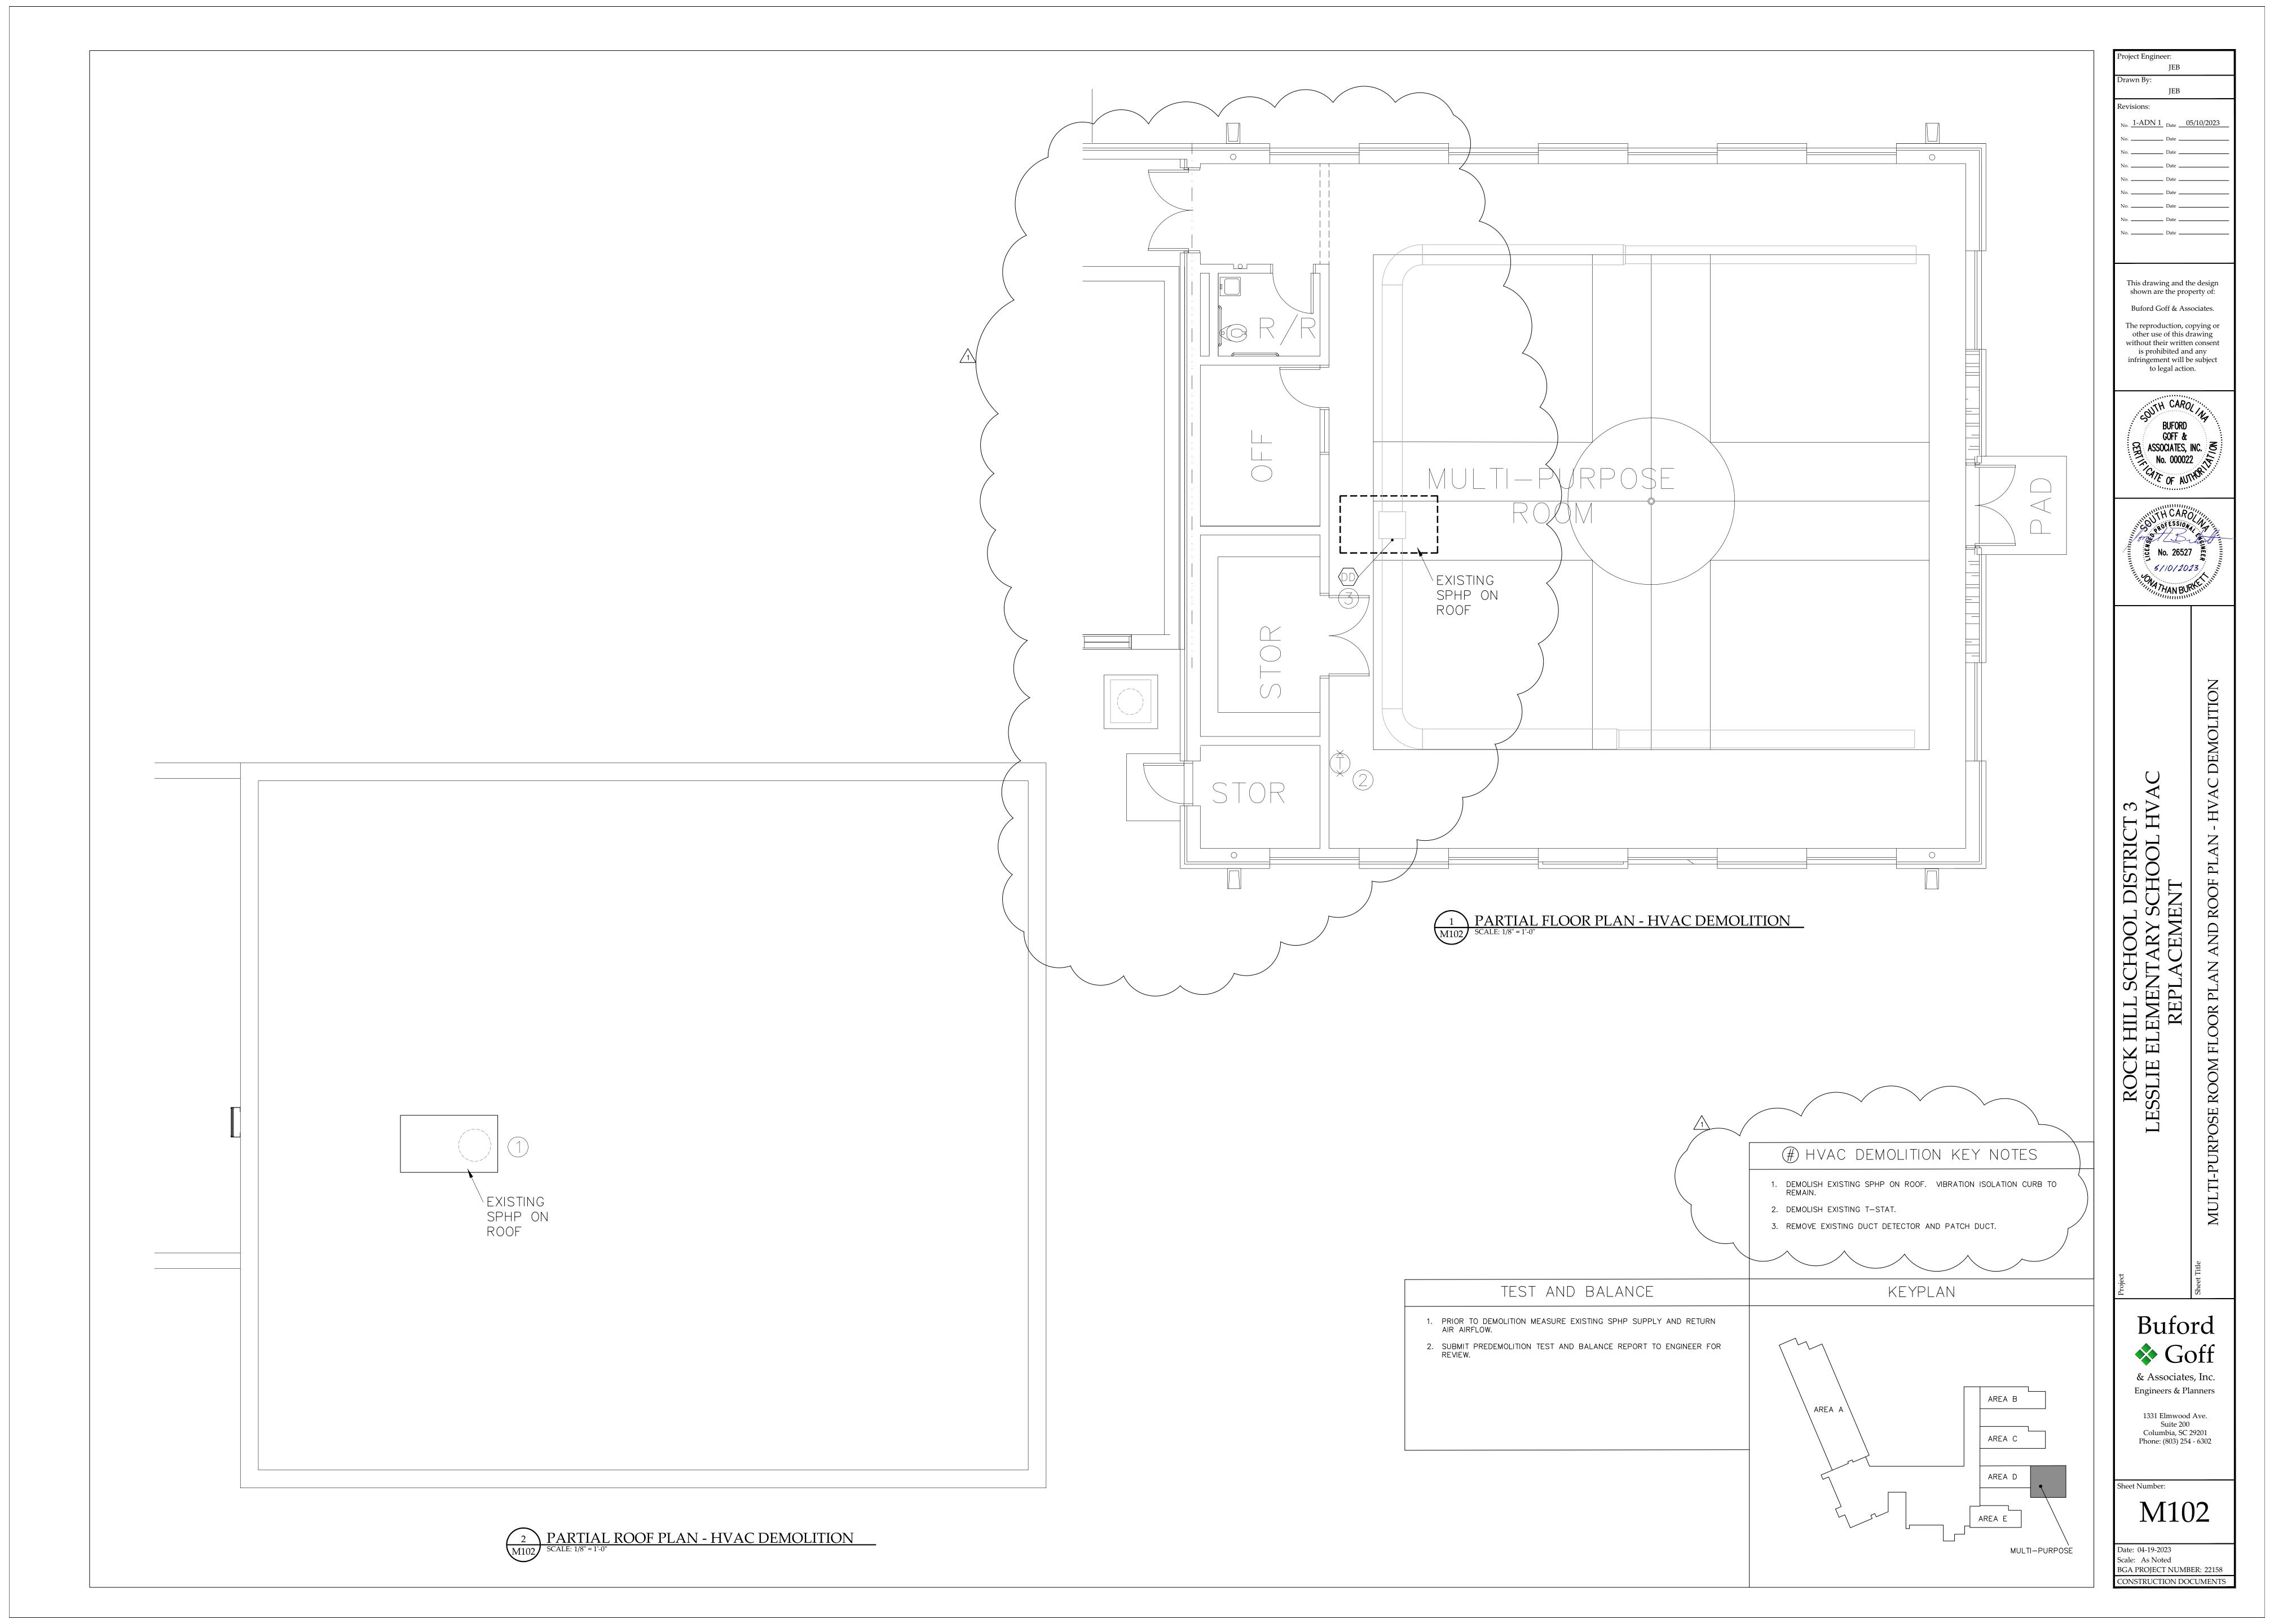
Buford Goff & Associates, Inc.


Engineers & Planners 1331 Elmwood Ave. Suite 200

Columbia, SC 29201 Phone: (803) 254 - 6302

Sheet Number:

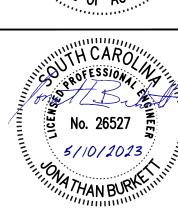Date: 04-19-2023 Scale: As Noted BGA PROJECT NUMBER: 22158 CONSTRUCTION DOCUMENTS

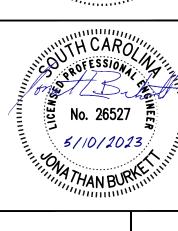

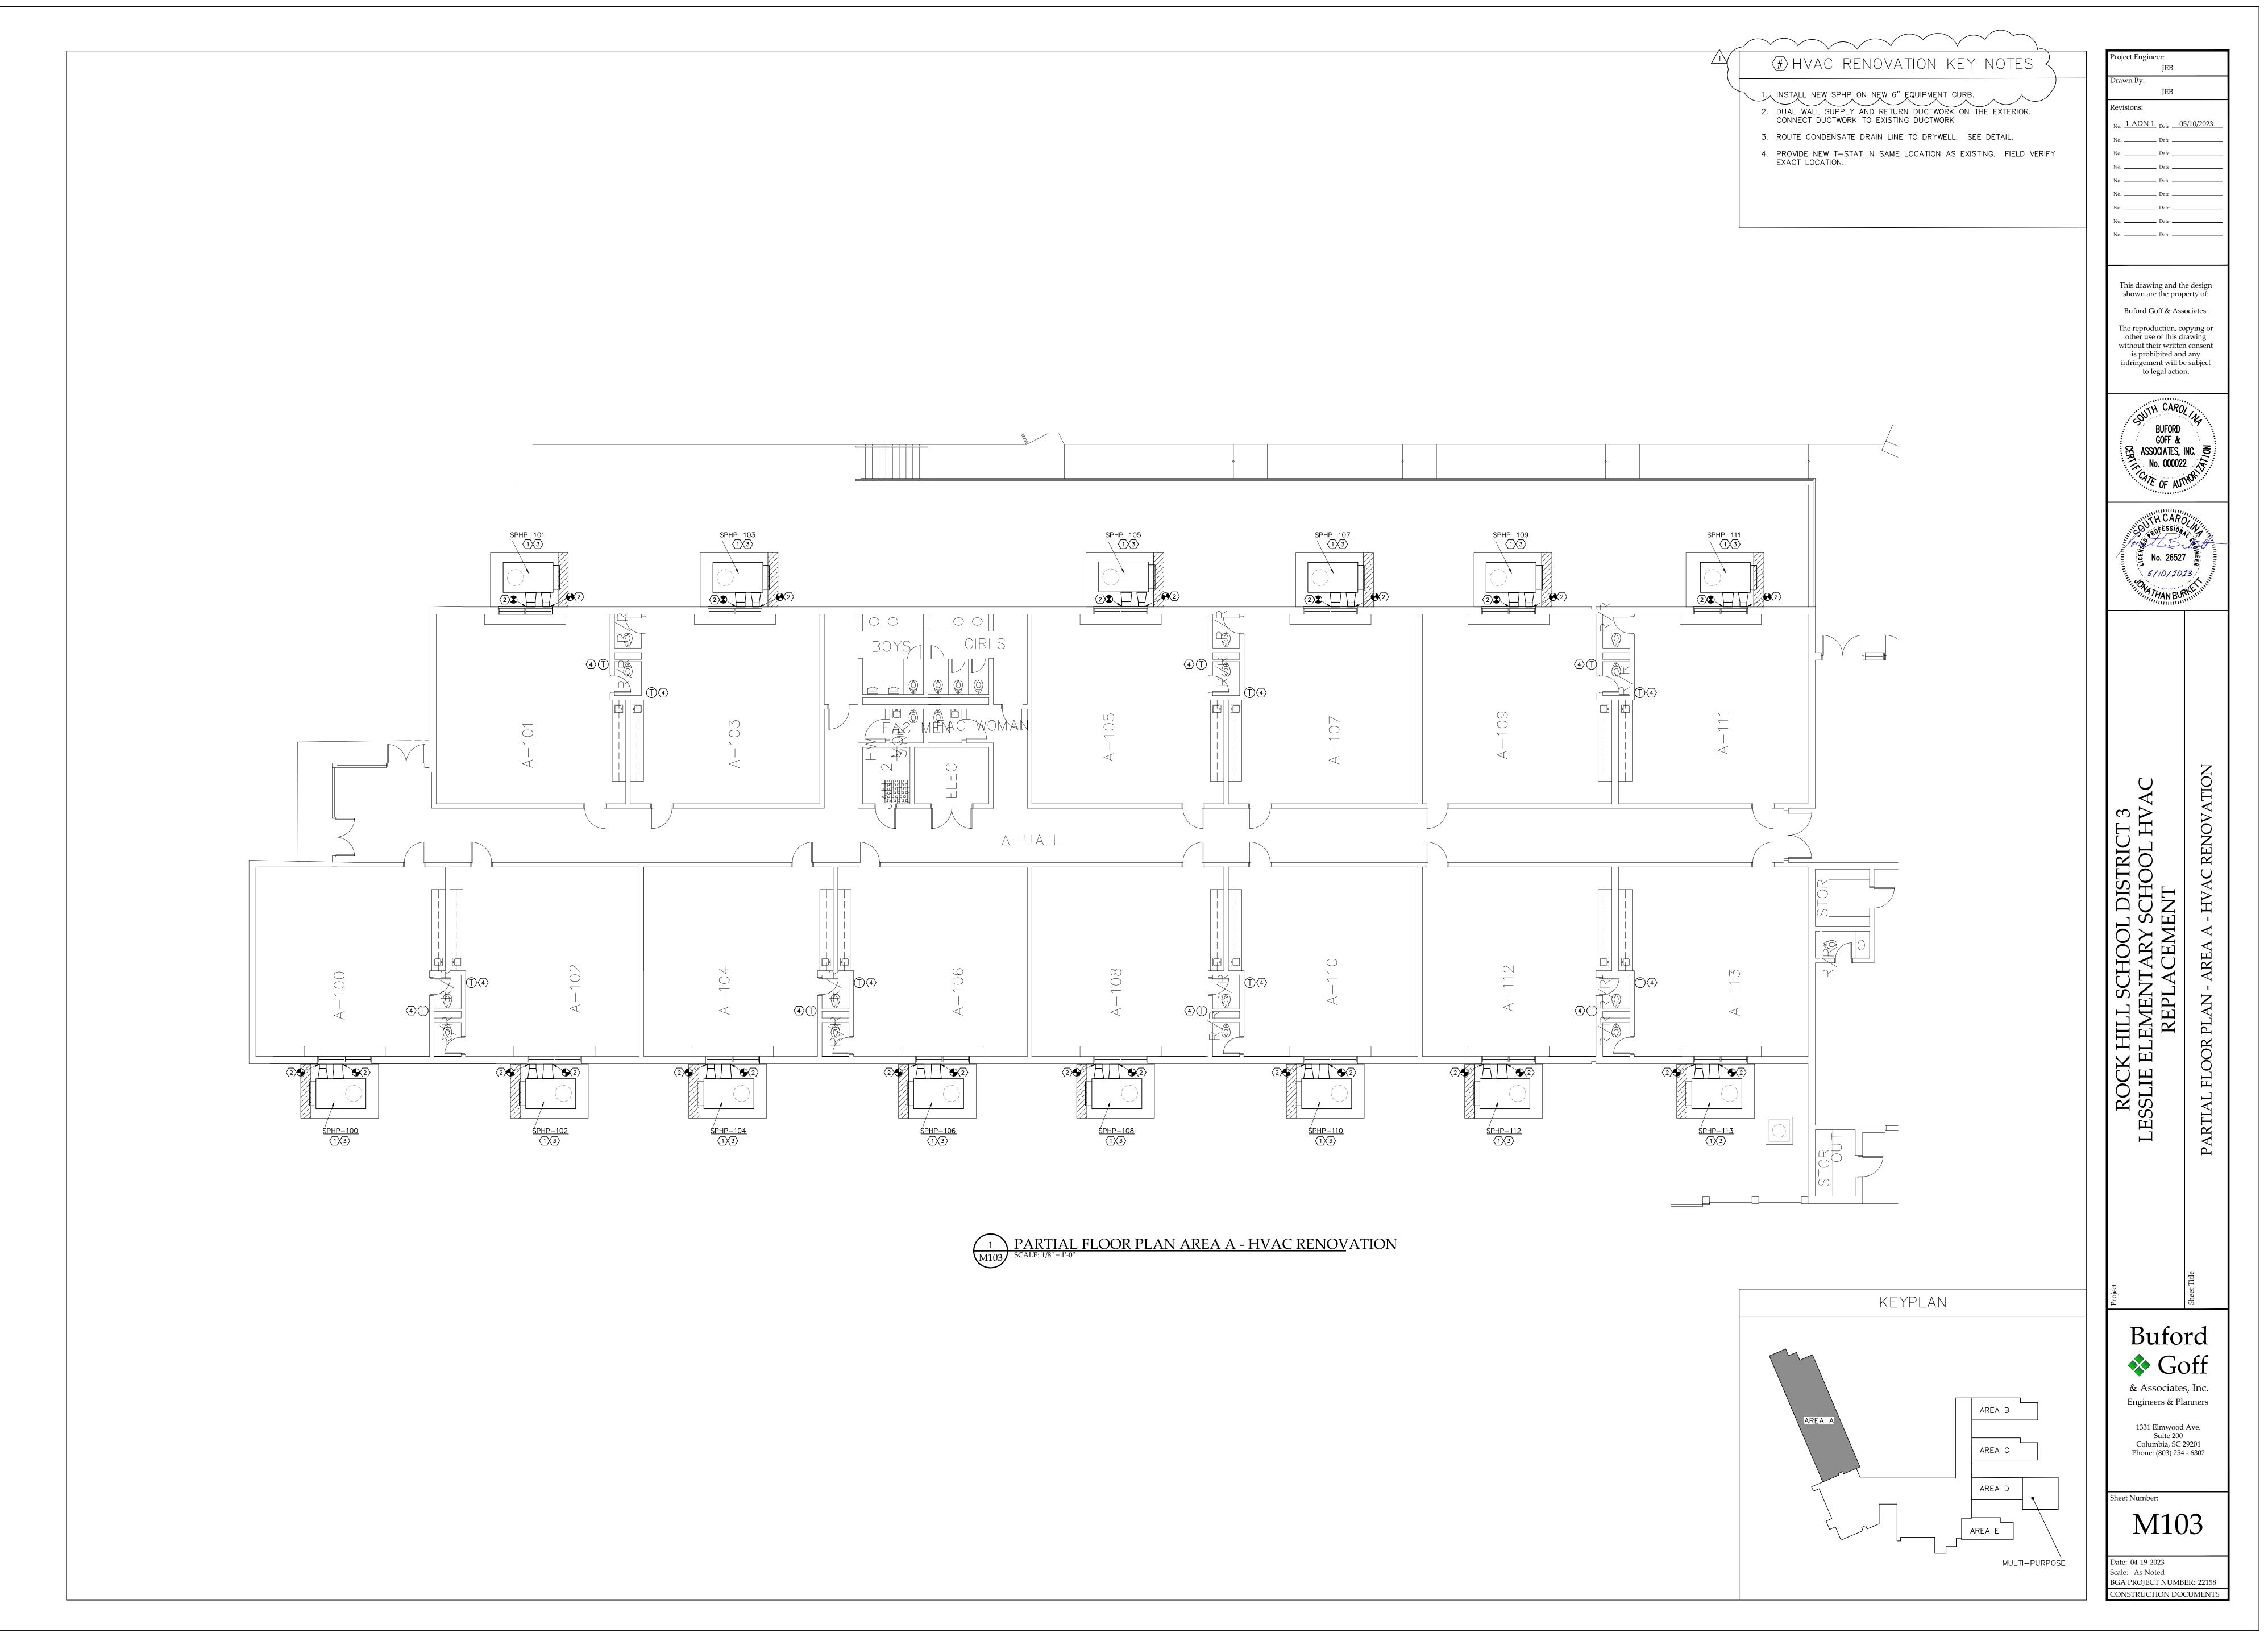

MECHANICAL GENERAL NOTES

- 1. DO NOT SCALE DRAWINGS, (SEE ARCHITECTURAL DRAWINGS AND REFLECTED CEILING PLANS FOR EXACT LOCATIONS)(FIELD VERIFY EXISTING CONDITIONS) OF DOORS, WINDOWS, CEILING DIFFUSERS,
- 2. EXTEND ALL DRAIN LINES TO NEAREST GUTTER ON ROOF OR AS INDICATED ON PLANS. CONDENSATE DRAINS SHALL BE TRAPPED. ROUTE TO MINIMIZE TRIPPING HAZARD. PROVIDE CLEANOUTS AT ALL CHANGES OF DIRECTION GREATER THAN 90
- 3. ALL PIPING AND DUCTWORK INSULATION SHALL BE RUN CONTINUOUSLY THROUGH FLOORS, AND PARTITIONS EXCEPT WHERE PROHIBITED BY FIRE CODES.
- 4. LOCATE ALL THERMOSTATS, HUMIDISTATS AND SWITCHES 48"(TO TOP OF DEVICE) ABOVE FINISH FLOOR.
- 5. ALL PIPING SHALL BE SUPPORTED IN ACCORDANCE WITH THE SPECIFICATIONS. HANGERS SHALL BE ADJACENT TO ELBOWS AND AT EQUIPMENT TO PREVENT WEIGHT OF PIPING BEING PLACED ON THE EQUIPMENT. SUPPORT DETAILS SHALL BE SUBMITTED TO THE MECHANICAL ENGINEER.
- 6. ALL PIPING AND DUCTWORK LOCATIONS SHALL BE COORDINATED WITH THE WORK UNDER OTHER DIVISIONS OF THE SPECIFICATIONS
- 7. AIR DISTRIBUTION SYSTEMS WITH MORE THAN ONE BRANCH, OR MULTIPLE OUTLETS ON A BRANCH, SHALL HAVE VOLUME DAMPERS TO BALANCE AIR FLOWS. SPIN IN FITTINGS ARE PERMITTED FOR CONNECTING FLEX DUCT TO BRANCH OR TRUNK DUCTS WHERE FLEX DUCTS ARE INDICATED. IF FLEX DUCT CANNOT BE CONNECTED WITH A SPIN IN, A HARD DUCTED TAKEOFF MUST BE PROVIDED.
- 8. 45 DEGREE TAKEOFFS SHALL BE USED ON ALL HARD DUCTED SUPPLY BRANCHES.
- 9. ALL PIPING, DUCTS, VENTS, ETC. EXTENDING THRU EXTERIOR WALLS AND ROOFS SHALL BE FLASHED AND COUNTERFLASHED.
- 10. PROVIDE ALL TRANSITIONS REQUIRED FOR INSTALLATION OF DUCT, DUCT HEATERS, AIR VOLUME CONTROLLERS, AIR HANDLING UNITS, FANS, AND ALL OTHER EQUIPMENT AND APPURTENANCES.
- 11. PROVIDE INSULATED BLANK-OFF PANEL FOR ALL UNUSED PORTION OF LOUVER (WHICH HAVE MECHANICAL DUCT
- CONNECTIONS). 12. ALL TRANSFER DUCTS SHALL BE LINED WITH ONE INCH
- ACOUSTICAL LINER. 13. ALL DUCTS SERVING THE THEATRE, STAGE, 2ND STAGE AND
- LOBBY SHALL BE LINED WITH 2 INCH ACOUSTICAL LINER. 14. ALL DUCT IS GALVANIZED SHEETMETAL EXCEPT AS NOTED.
- 15. DUCT SIZES ARE CLEAR INSIDE DIMENSIONS.
- 16. INTAKES FOR AIR HANDLING EQUIPMENT SHALL BE A MINIMUM OF FIFTEEN FEET AWAY FROM ANY EXHAUST OR VENT. 17. AIR DISTRIBUTION UNITS SHALL HAVE TRIM REQUIRED FOR
- 18. ALL EQUIPMENT SHALL MEET THE PROJECT'S SEISMIC DESIGN AND WIND LOAD REQUIREMENTS.

FINISHED SERVICE.

SEISMIC DESIGN				
	SEISMIC DESIGN CATEGORY (SDC): C			
	RISK CATEGORY: III			
	SPECTRAL RESPONSE COEFFICIENTS Sds: 0.255; Sd1: 0.144			
1	ID DESIGN			
	BASIC WIND SPEED: 120 MPH			
	EXPOSURE CATEGORY: C			
	RISK CATEGORY: III			

DUCT PRESSURE CLASSIFICATION							
DUCT	SYSTEM	PRESSURE	STATIC PRESSURE CLASS ("WG)				
RETURN DUCT	ALL SYSTEM RETURNS	NEG	-2"				
SUPPLY DUCT	ALL SYSTEM SUPPLY	POS	+2"				
			S3958				

MECHANICAL SYMBOL LEGEND SUPPLY OR OUTSIDE AIR GRILLE ■ BACS-1 BUILDING AUTOMATION CONTROL SYSTEM NO. RETURN AIR GRILLE THERMOSTAT/SENSOR EXHAUST AIR GRILLE DUCT TURNED TO HUMIDISTAT/HUMIDITY SENSOR DUCT TURNED AWAY FLEX CONNECTION (DUCT) DUCT CAPPED FILTER SECTION EQUIPMENT LOCATED ON ROOF DUCT SMOKE DETECTORS 10x8 INSIDE DUCT DIMENSION CONTROL WIRING OPPOSED BLADE VOLUME DAMPER AD L ACCESS DOOR FIRE DAMPER (FUSIBLE LINK) 120V POWER IN J-BOX AIR DISTRIBUTION (OTHER SYMBOLS SIM.) MOTORIZED DAMPER ■ LS LIGHT SWITCH CONCEALED REGULATOR ■ CO₂ CO₂ SENSOR POUNDS (OR NUMBER) FACP FIRE ALARM CONTROL PANEL 10"ø 10" ROUND DUCT (INSIDE DIM)

ABV	ABOVE	IN	INCHES
AFF	ABOVE FINISH FLOOR	MOD	MOTOR OPERATED DAMPER
AFMS-1	AIRFLOW MEASURING STATION NO.1	MPS	MEDIUM PRESSURE STEAM (16 PSI TO 30 PSI
BACS	BUILDING AUTOMATION CONTROL SYSTEM	NO	NORMALLY OPEN
BHP	BRAKE HORSE POWER	NC	NORMALLY CLOSED
BOD	BOTTOM OF DUCT	ОС	ON CENTER
BOP	BOTTOM OF PIPE	ODAC-1	OUTDOOR AIR CONDITIONING UNIT NO.1
CEF-1	CEILING EXHAUST FAN NO. 1	ODHP-1	OUTDOOR HEAT PUMP NO.1
CFM	CUBIC FEET PER MINUTE	ODP	OPEN DRIP PROOF
CLG	CEILING	PD	PRESSURE DROP
CO	CLEAN OUT	PFD	PIPE TO FLOOR DRAIN
D	DRAIN	PH	PHASE
EF-1	EXHAUST FAN NO.1	REF.	REFRIGERANT LINES
EFF	EFFICIENCY	SF	SQUARE FOOT
ELECT	ELECTRICAL	SP	STATIC PRESSURE SENSOR
ESP	EXTERNAL STATIC PRESSURE	SPAC-1	SINGLE PACKAGE AIR CONDITIONING UNIT NO.
EUH-1	ELECTRIC UNIT HEATER NO.1	T-1	TERMINAL UNIT NO. 1
	ELECTRIC WALL HEATER NO.1	TA	THROW AWAY (FILTER)
EWH-1		TC	TIME CONTROL
EXT	EXTERNAL	TD	TRANSFER DUCT
FPS	FEET PER SECOND	TEAO	TOTALLY ENCLOSED AIR OVER
FT	FEET	TEFC	TOTALLY ENCLOSED FAN COOLED
FLR	FLOOR	UNO	UNLESS NOTES OTHERWISE
HP	HORSE POWER	VFD	VARIABLE FREQUENCY DRIVE
IDAC-1	INDOOR AIR CONDITIONING UNIT NO.1	VEL	VELOCITY
IDHP-1	INDOOR HEAT PUMP NO.1	VOLT	VOLTAGE
		WMHP-1	WALL MOUNTED HEAT PUMP NO. 1
		2P0S	TWO POSITION

SINGLE PACKAGE HEAT PUMP UNIT SCHEDULE FANS COMPRESSOR ELECTRIC HEAT COOLING COIL CAPACITY HEATING COIL CAP | MAX. MANUFACTURER WEIGHT OUTDOOR INDOOR ENT AIR | LVG AIR CONDITIONER REMARKS KW |VOLT/PH| AND MODEL DB T DB WB DB WB TOT OA 2345 78910 121314 1280 0.6 | 1 | 0.62 | 1.5 | 1 | 5.7 | 12 | 480/3 | 36.8 | 29.0 | 95 | 80.0 | 67.1 | 57.3 | 57.2 | 12.5 | 47 | 31.6 | 3.6 | 700 | SPHP-A100 1.0 TRANE WHC036
 2345

 78910

 121314

 2345

 78910

 121314
 12 | 480/3 | 36.8 | 29.0 67.1 57.3 57.2 SPHP-A101 TRANE WHC036 57.2 SPHP-A102 480/3 36.8 31.6 3.6 TRANE WHC036 2 3 4 5 7 8 9 10 12 13 14 2 3 4 5 7 8 9 10 12 13 14 2 3 4 5 7 8 9 10 12 13 14 2 3 4 5 7 8 9 10 12 13 14 2 3 4 5 7 8 9 10 12 13 14 2 3 4 5 7 8 9 10 12 13 14 2 3 4 5 7 8 9 10 12 13 14 2 3 4 5 7 8 9 10 12 13 14 2 3 4 5 7 8 9 10 12 13 14 2 3 4 5 7 8 9 10 12 13 14 2 3 4 5 7 8 9 10 12 13 14 2 3 4 5 7 8 9 10 12 13 14 2 3 4 5 7 8 9 10 12 13 14 2 3 4 5 7 8 9 10 12 13 14 2 3 4 5 7 8 9 10 12 13 14 2 3 4 5 7 8 9 10 12 13 14 2 3 4 5 7 8 9 10 12 13 14 150 0.62 36.8 80.0 67.1 57.3 57.2 31.6 TRANE WHC036 SPHP-A103 47 31.6 3.6 SPHP-A104 480/3 36.8 67.1 57.3 57.2 TRANE WHC036 67.1 57.3 57.2 700 150 0.62 80.0 31.6 1 5.7 12 480/3 36.8 TRANE WHC036 SPHP-A105 67.1 57.3 57.2 31.6 SPHP-A106 480/3 36.8 TRANE WHC036 150 0.62 36.8 57.3 57.2 31.6 700 SPHP-A107 TRANE WHC036 SPHP-A108 36.8 67.1 57.3 57.2 31.6 TRANE WHC036 57.3 0.62 36.8 29.0 SPHP-A109 57.2 31.6 TRANE WHC036 36.8 57.2 TRANE WHC036 150 36.8 29.0 57.3 SPHP-A111 57.2 TRANE WHC036 36.8 57.2 TRANE WHC036 150 0.62 12 480/3 36.8 29.0 80.0 67.1 57.3 57.2 12.5 28 30 480/3 TRANE WHC036 123 5 789101112 1.0 | 3000 | 600 | 1.6 | 1 | 1.26 | 2.75 | 2 | 7.6/6.3 | 18 | 480/3 | 99.8 | 72.4 | 79.0 | 66.6 | 55.1 | 55.0 | 12.0 50 480/3 TRANE WHC102

* INCLUDES DUCT, GRILLES, AND LOADED FILTERS (a) INCHES WG (b) @ ARI CONDITIONS

4)2 STAGE COMPRESSOR

(5) STAGED ELECTRIC HEAT

(7)LON COMMUNICATION CARD (8) LOW LEAK INSULATED OA DAMPER

9 DIRECT DRIVE FAN MOTOR (10) FACTORY CIRCUIT BREAKER (WITH OVERCURRENT PROTECTION) (12) HAIL GUARD

11 UNPOWERED CONVENIENCE OUTLET 13 HORIZONTAL DISCHARGE (14) 6 INCH TALL CURB ON GRADE

JEB

IEB

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5/10/2023

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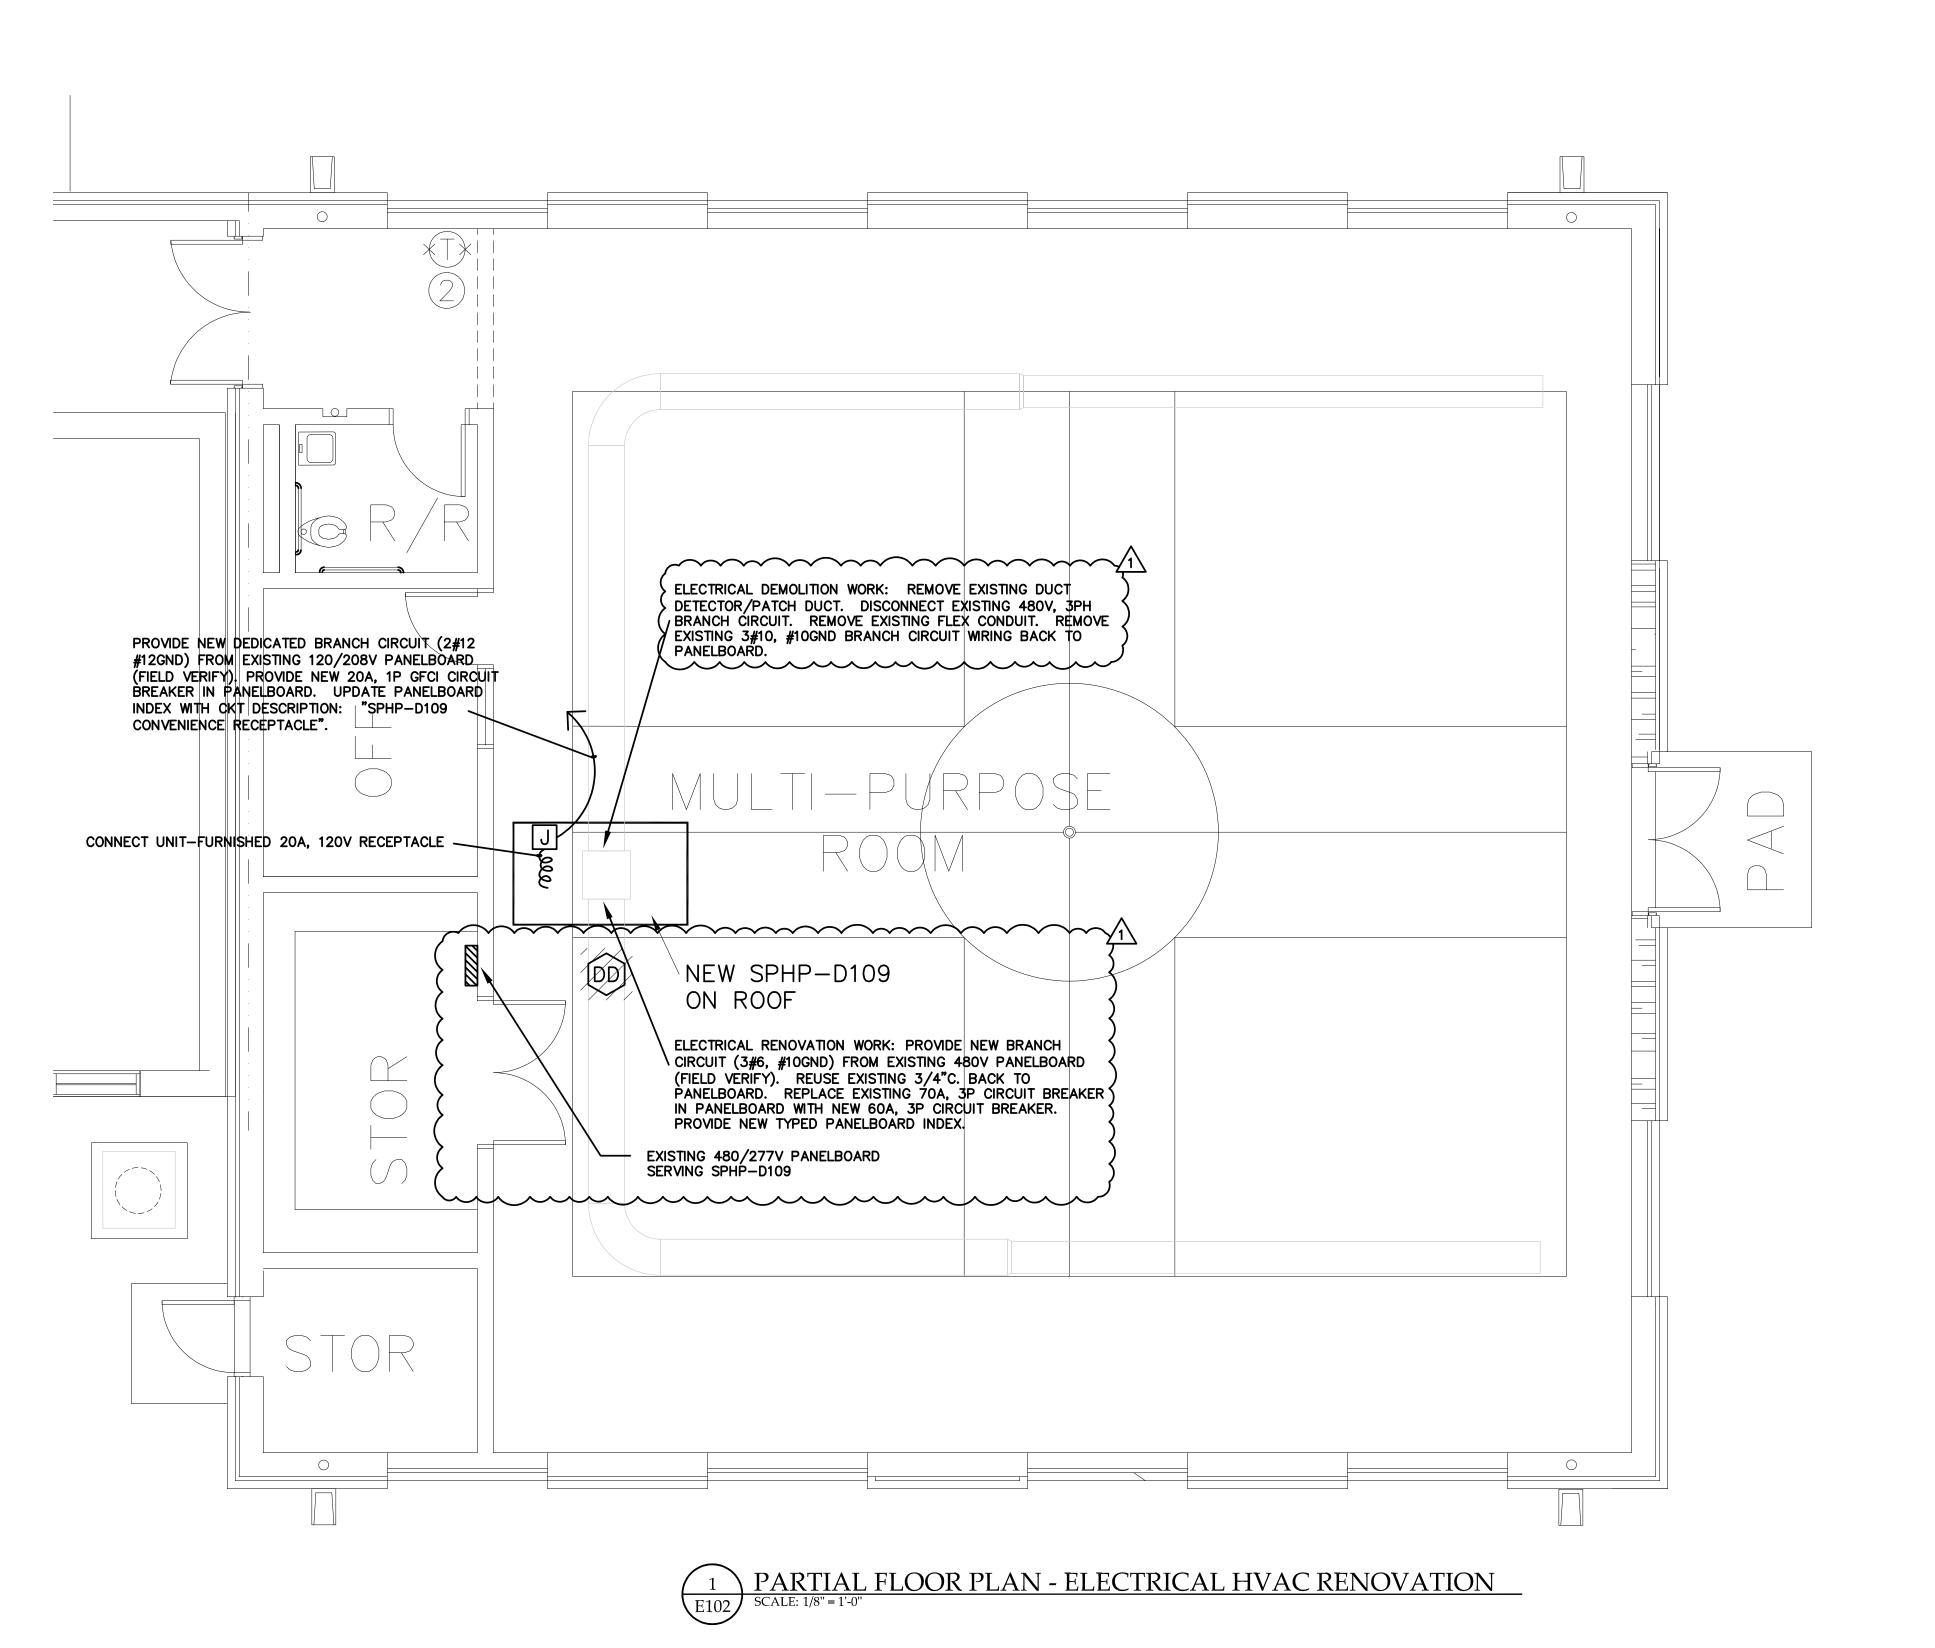
Buford Goff & Associates, Inc.

Engineers & Planners 1331 Elmwood Ave. Suite 200 Columbia, SC 29201 Phone: (803) 254 - 6302

Sheet Number:

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Scale: As Noted BGA PROJECT NUMBER: 22158 CONSTRUCTION DOCUMENTS



ELECTRICAL SYMBOL LEGEND

SYMBOL

DESCRIPTION

→ WP

20A, 125V, GFCI WET LOCATION DUPLEX RECEPTACLE. PROVIDE CAST WEATHER-PROOF, METAL BACKBOX.

JUNCTION BOX, SIZE PER NEC UNLESS SIZE NOTED

CONDUIT RUN OVERHEAD

AFF

ABOVE FINISHED FLOOR

C. CONDUIT

CB CIRCUIT BREAKER

→ KEYNOTE LABEL

X EQUIPMENT CONDUIT/CIRCUIT CONNECTION

SEALTIGHT FLEX CONNECTION TO MOTOR LOAD

SYMBOL LEGEND NOTES:


FOR MECHANICAL EQUIPMENT SHOWN TO BE DEMOLISHED, REMOVAL OF MECHANICAL EQUIPMENT IS UNDER DIVISION 23 SCOPE. DIVISION 26 SCOPE SHALL INCLUDE DISCONNECTION AND REMOVAL OF ELECTRICAL SERVICE TO MECHANICAL EQUIPMENT. SEE SPECIFICATION 260502 FOR MORE DETAILED SCOPE OF DEMOLITION WORK.

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LOCE LIVENCE

VAC RENOVATION

SOCK HILL SCHOOL DISTRICT 3
SLIE ELEMENTARY SCHOOL HV
REPLACEMENT

Buford

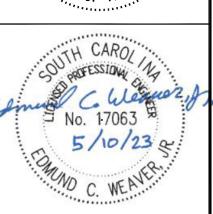& Associates, Inc.
Engineers & Planners

1331 Elmwood Ave.
Suite 200
Columbia, SC 29201
Phone: (803) 254 - 6302

Sheet Number:

E102

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